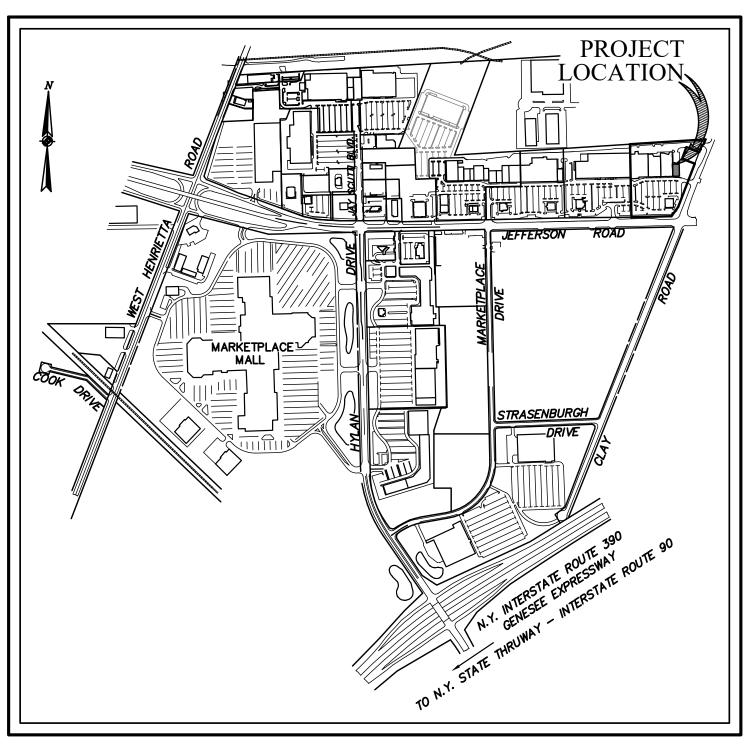
MARKET SQUARE (EAST) SITE DEVELOPMENT PLANS

8,600 SQ.FT. BUILDING EXPANSION 790 JEFFERSON ROAD

TOWN OF HENRIETTA COUNTY OF MONROE STATE OF NEW YORK

INDEX OF DRAWINGS

	H (BEIT of Biet) (II)
SHEET NO.	DRAWING TITLE
GA001	COVER SHEET (SHEET 1 OF 9)
CA100	OVERALL SITE PLAN (SHEET 2 OF 9)
CA110	EXISTING FEATURE / DEMOLITION AND SITE PLAN (SHEET 3 OF 9)
CA120	UTILITY, GRADING AND EROSION CONTROL PLAN (SHEET 4 OF 9)
CA130	MAINTENANCE AND PROTECTION OF TRAFFIC AND LANDSCAPE PLAN (SHEET 5 OF 9)
CA300	UTILITY PROFILE SHEET (SHEET 6 OF 9)
CA500	DETAIL SHEET (SHEET 7 OF 9)
CA501	DETAIL SHEET (SHEET 8 OF 9)
CA502	DETAIL SHEET (SHEET 9 OF 9)



LOCATION SKETCH

PREPARED FOR: **BENDERSON DEVELOPMENT. LLC 570 DELAWARE AVENUE BUFFALO, NEW YORK 14202** PHONE: (716) 878-3997



ENGINEERING Land SURVEYING

 LANDSCAPE **ARCHITECTURE**

217 LAKE AVENUE ROCHESTER, NY 14608 ENGINEERING

DATE: AUGUST 21, 2018

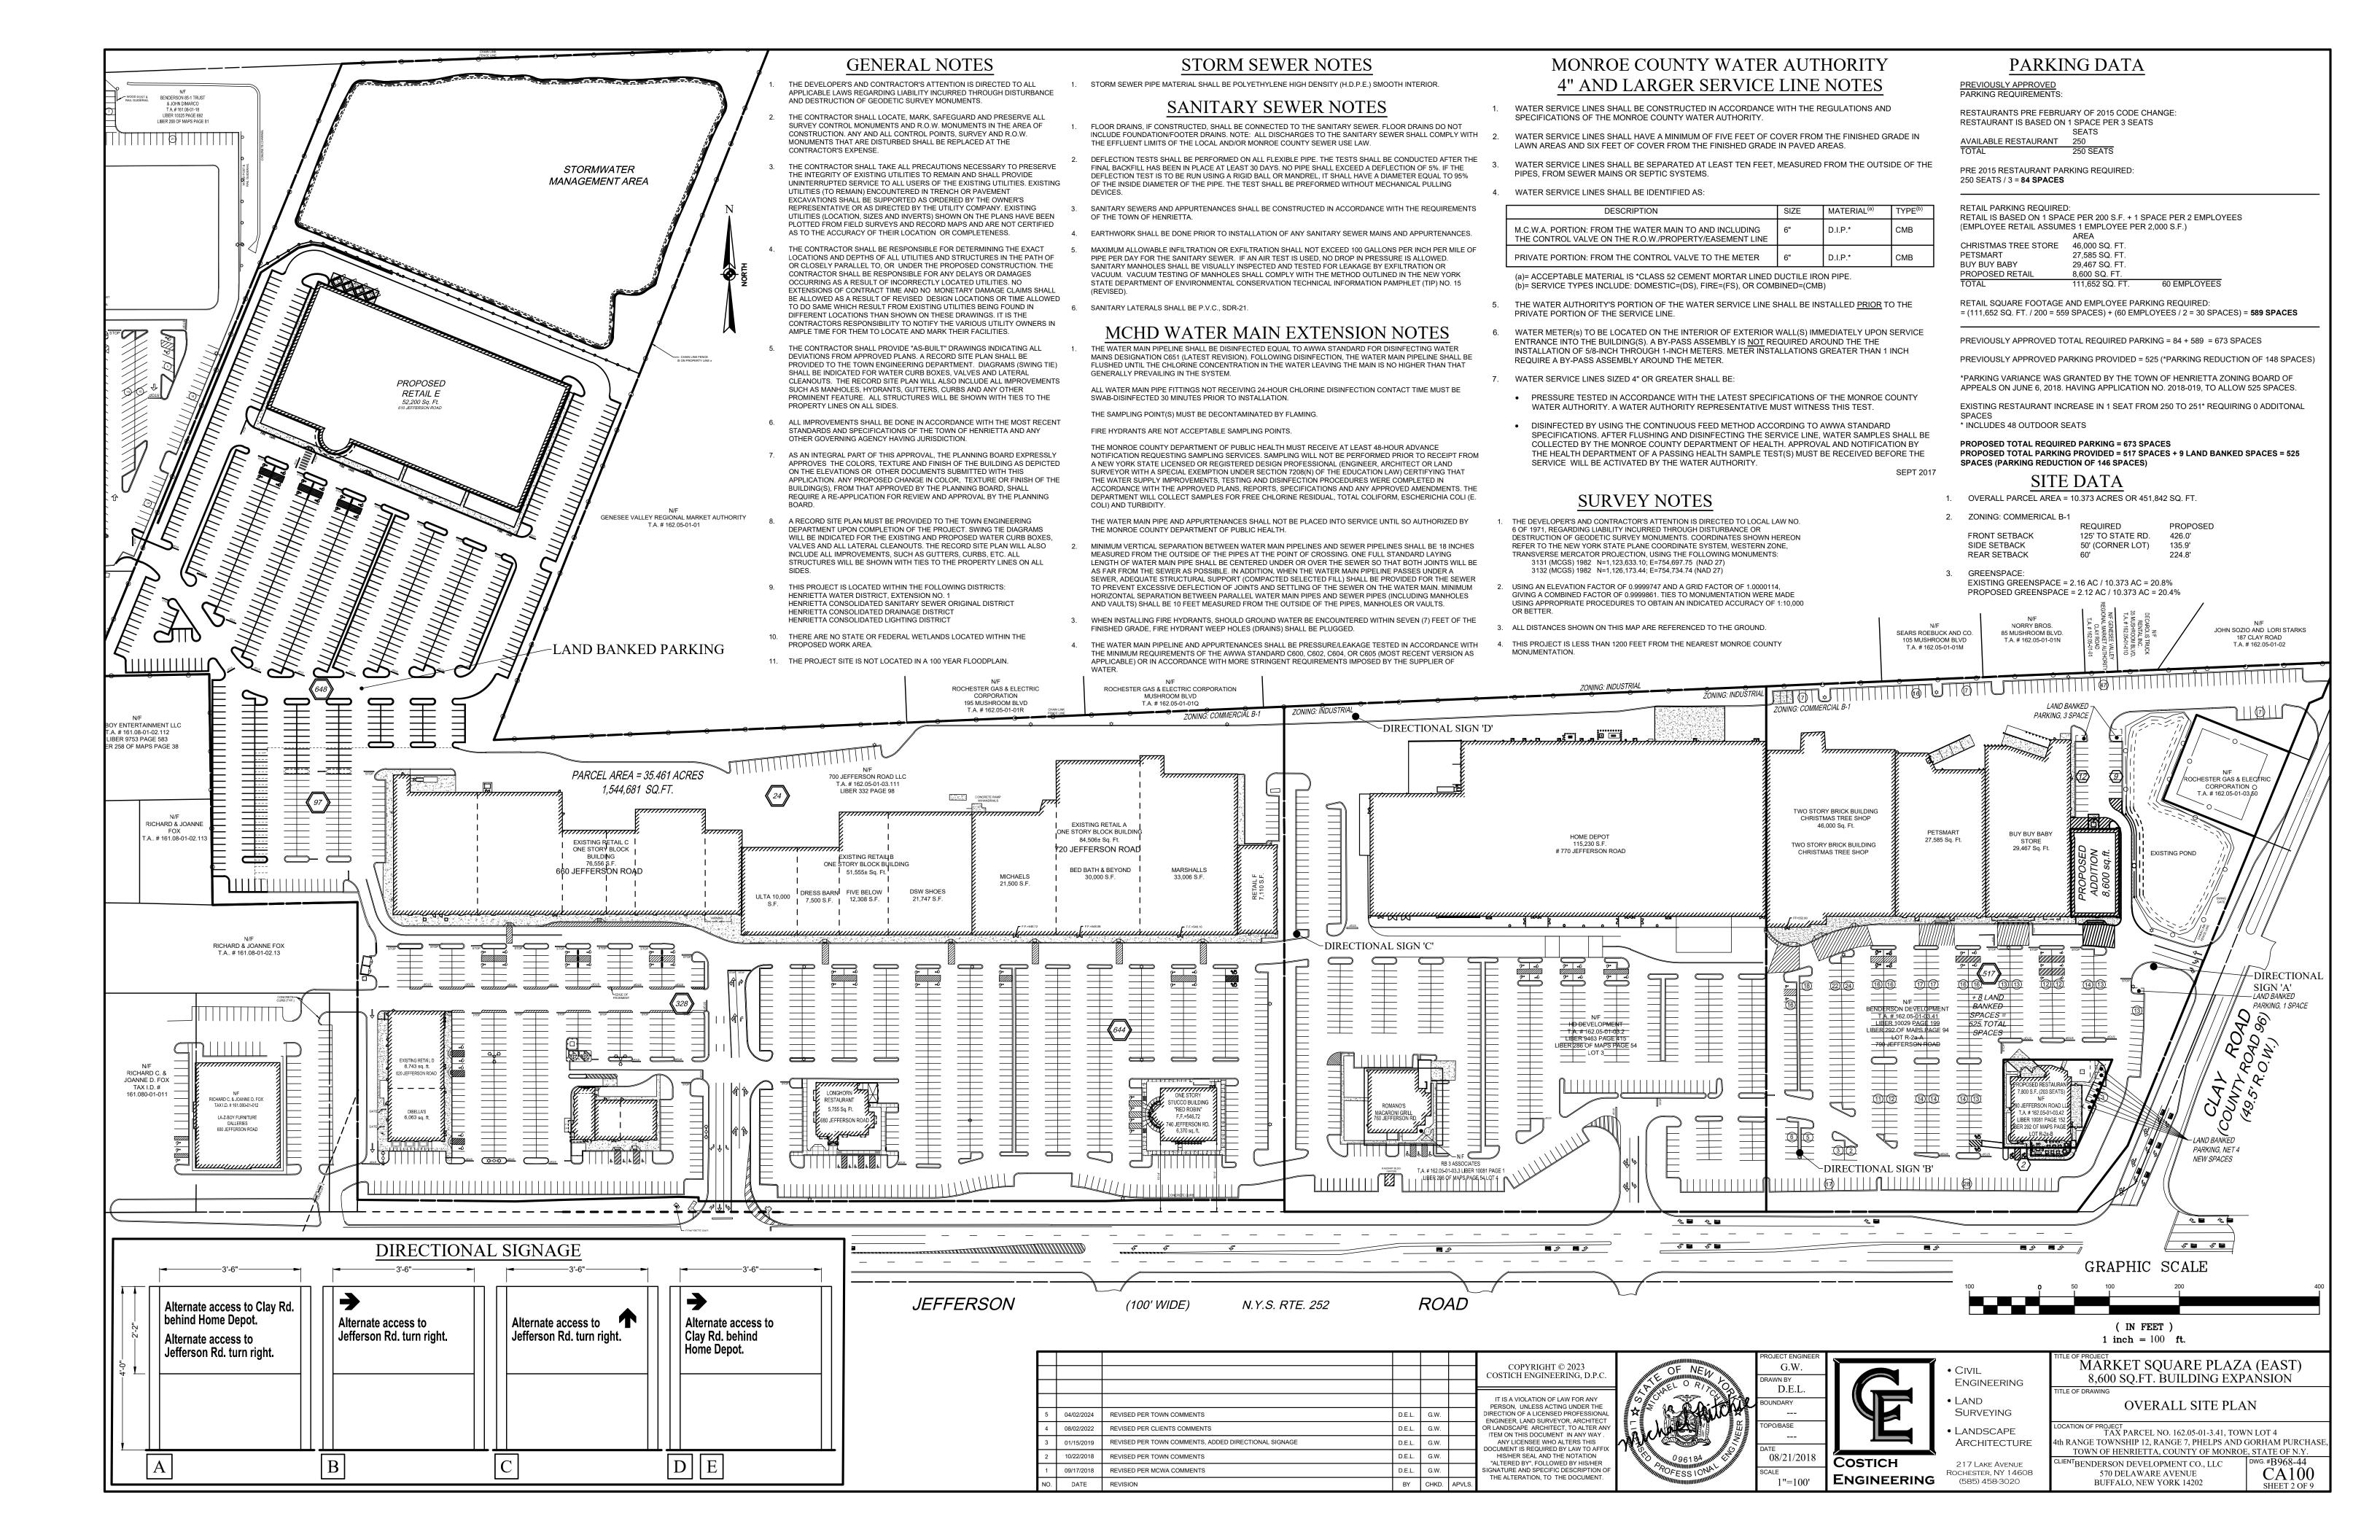


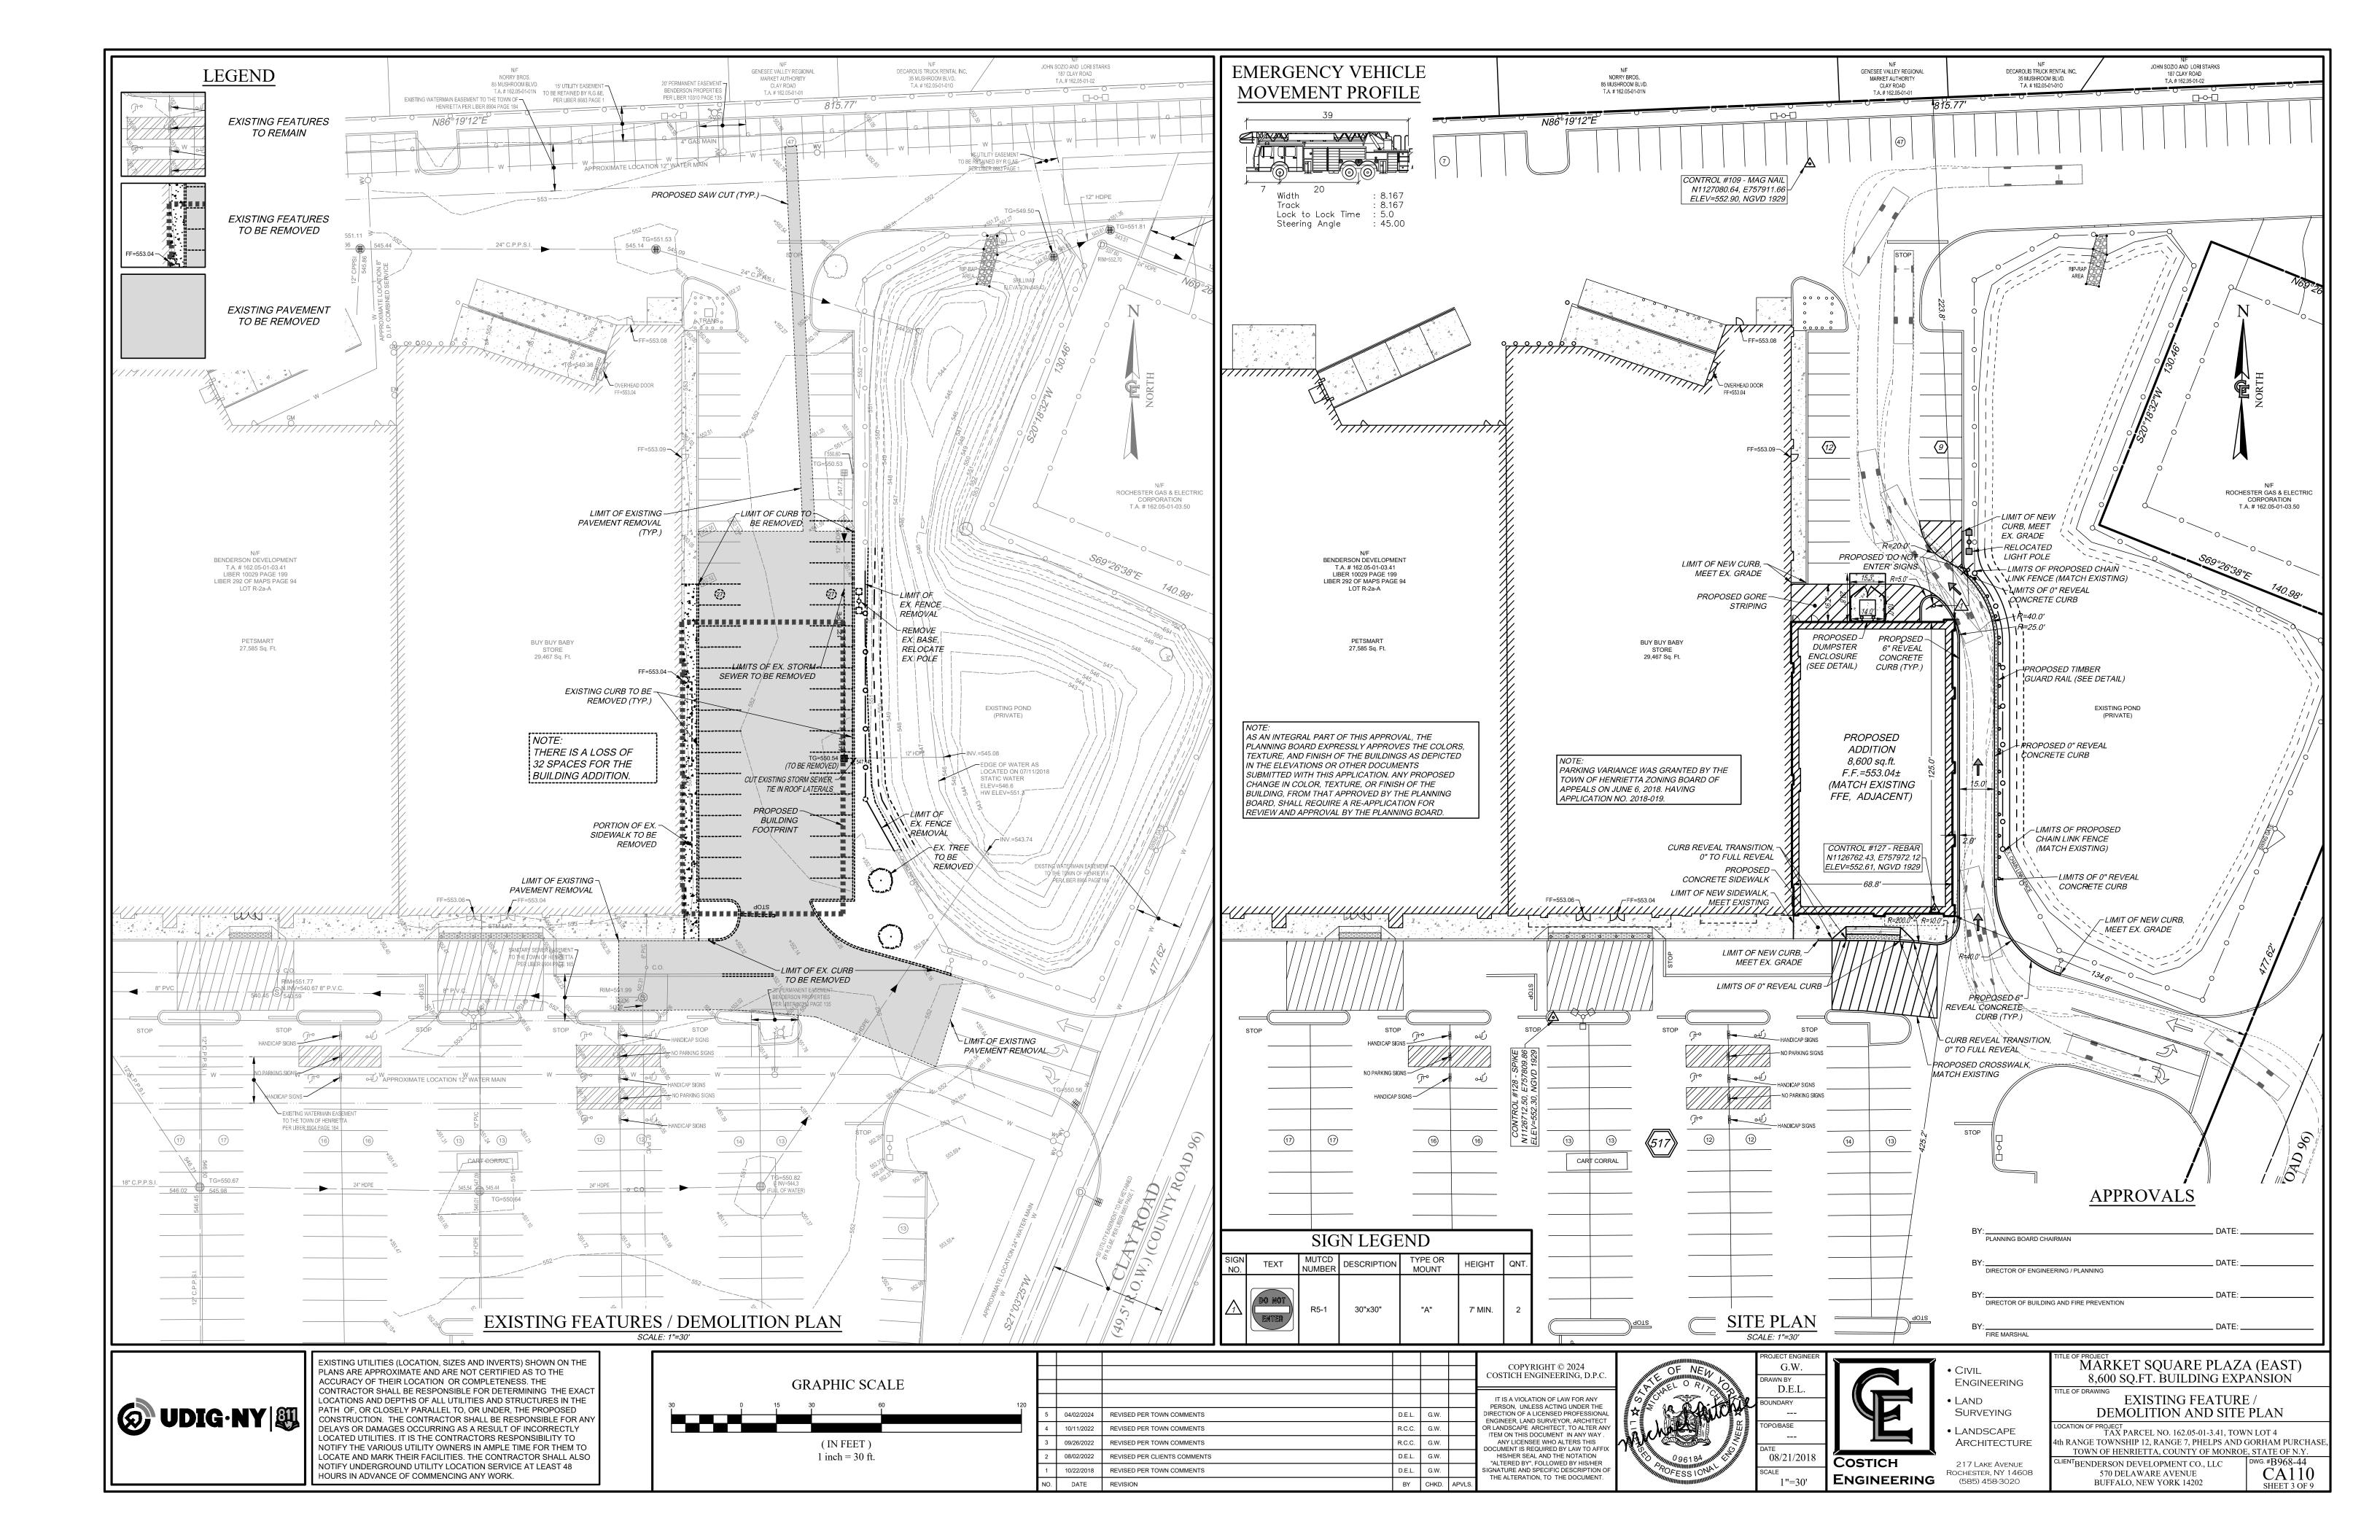
MARKET SQUARE (EAST)

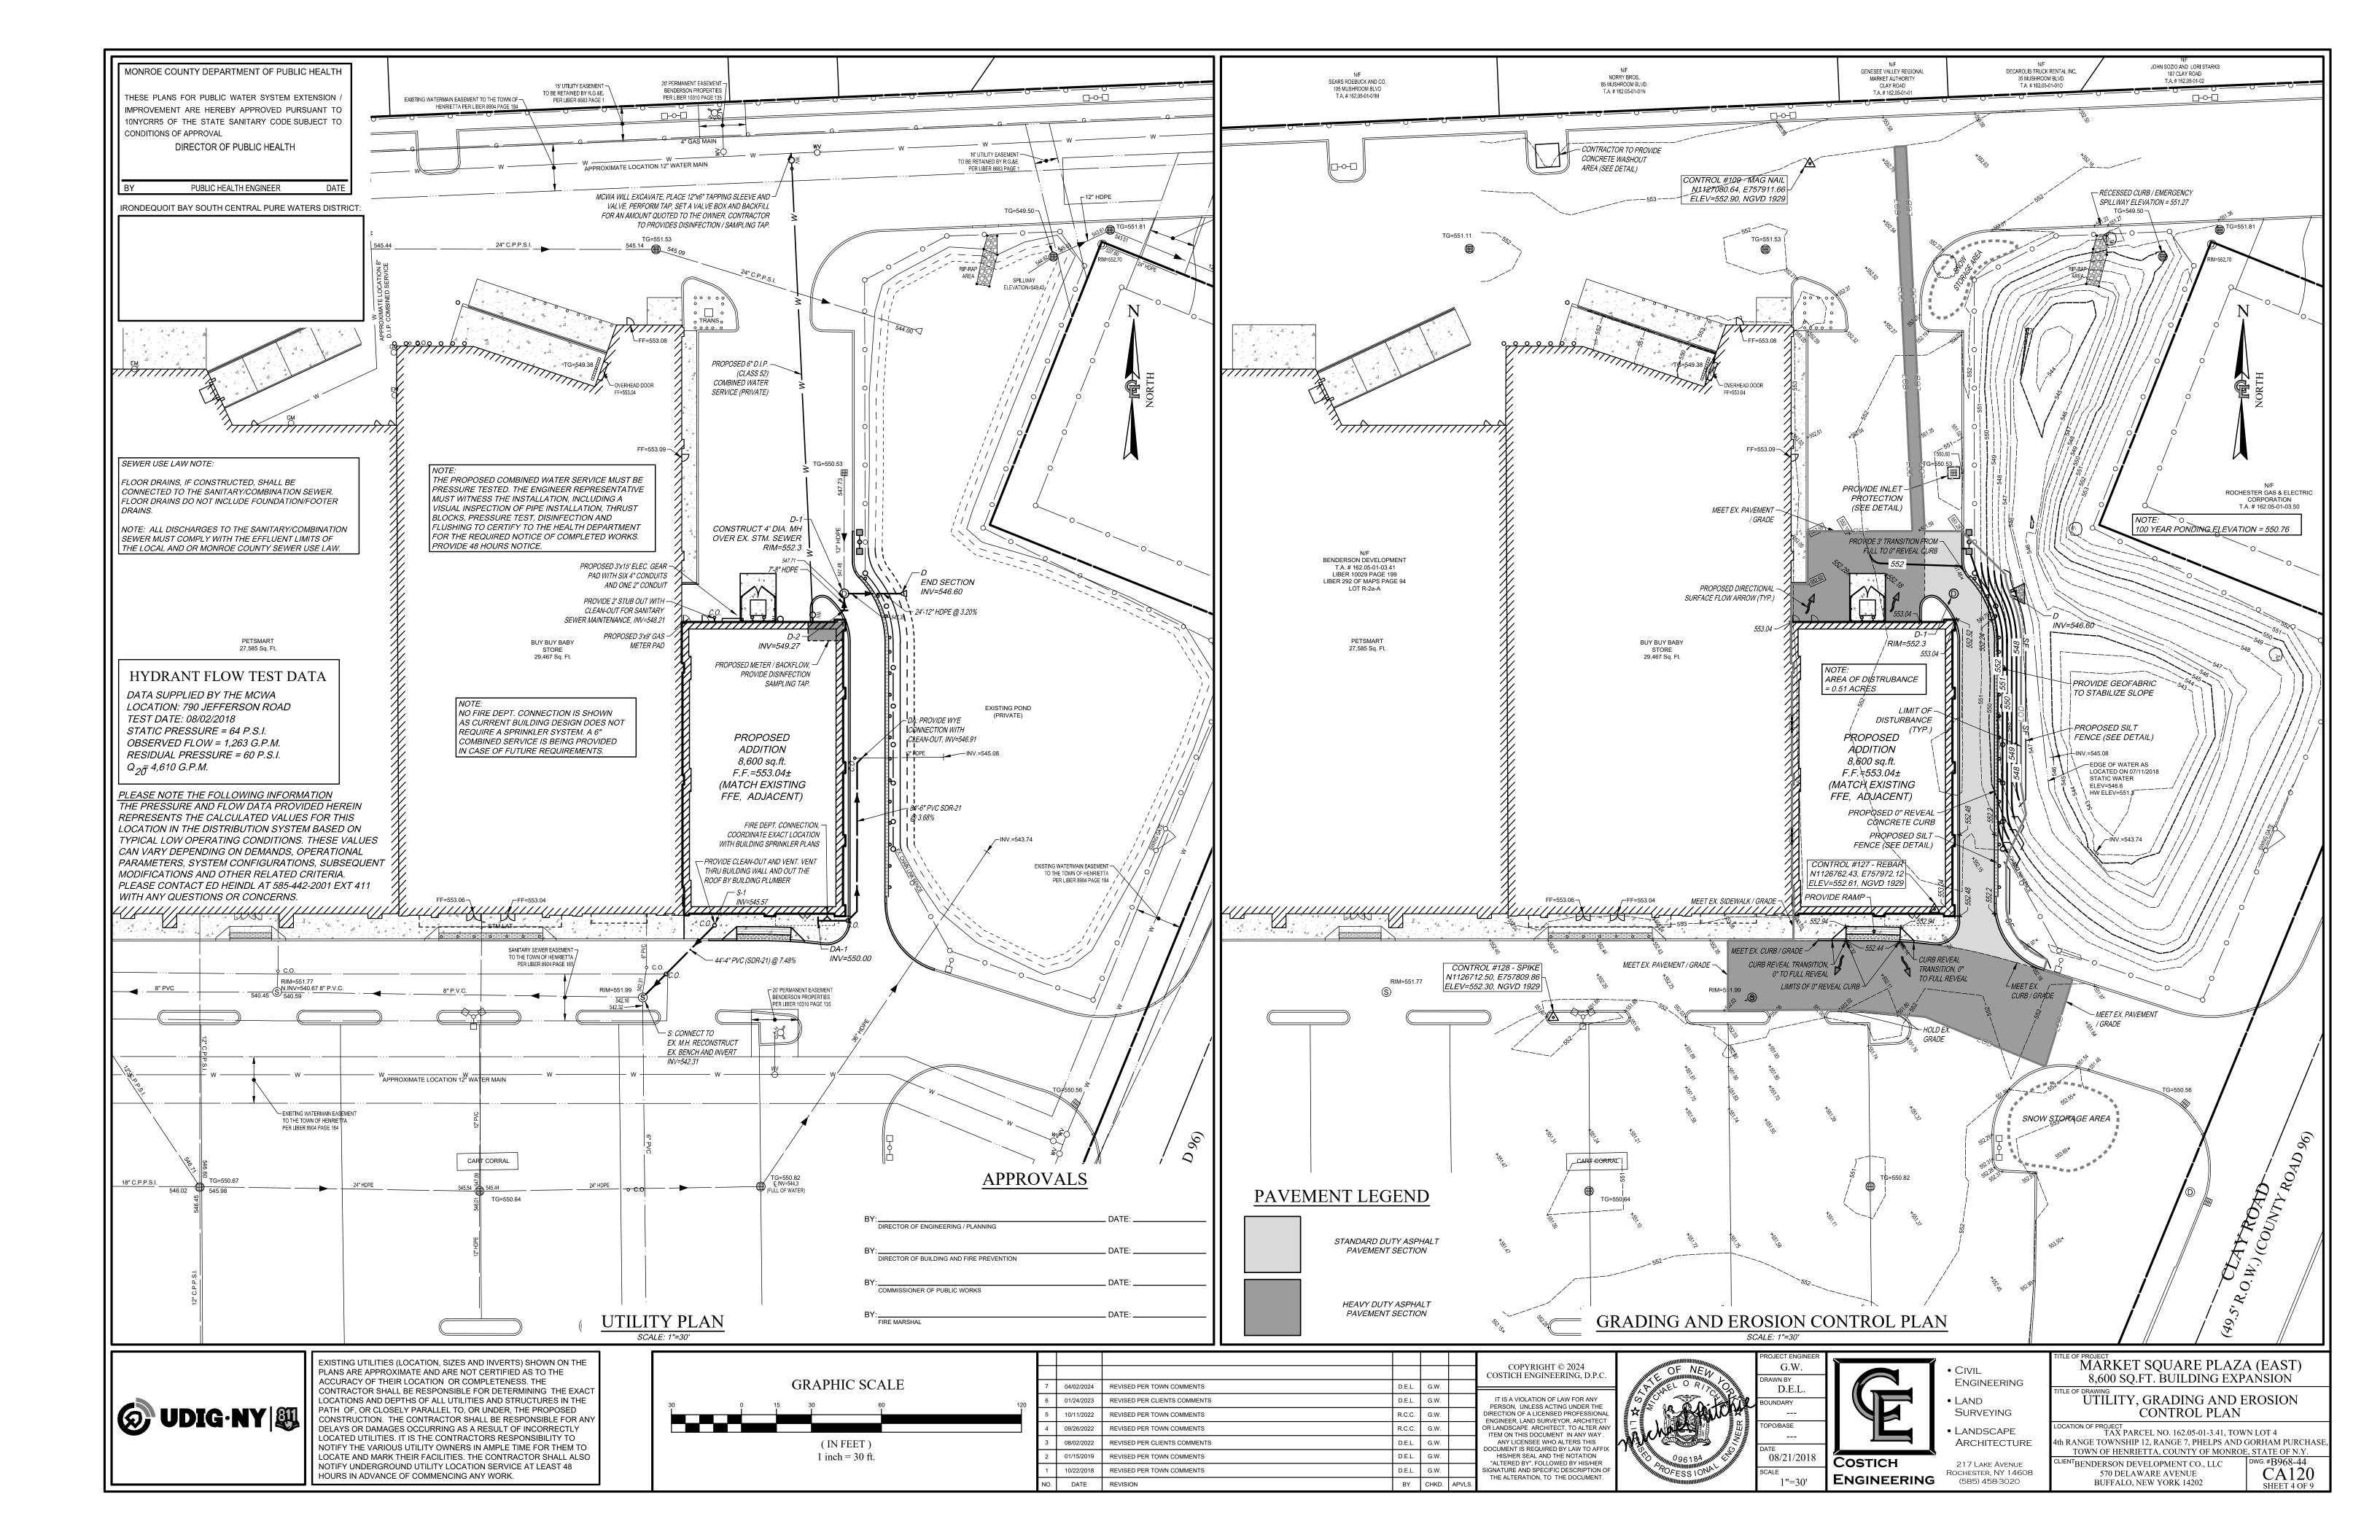
SITE DEVELOPMENT PLANS **8,600 SQ.FT. BUILDING EXPANSION 790 JEFFERSON ROAD**

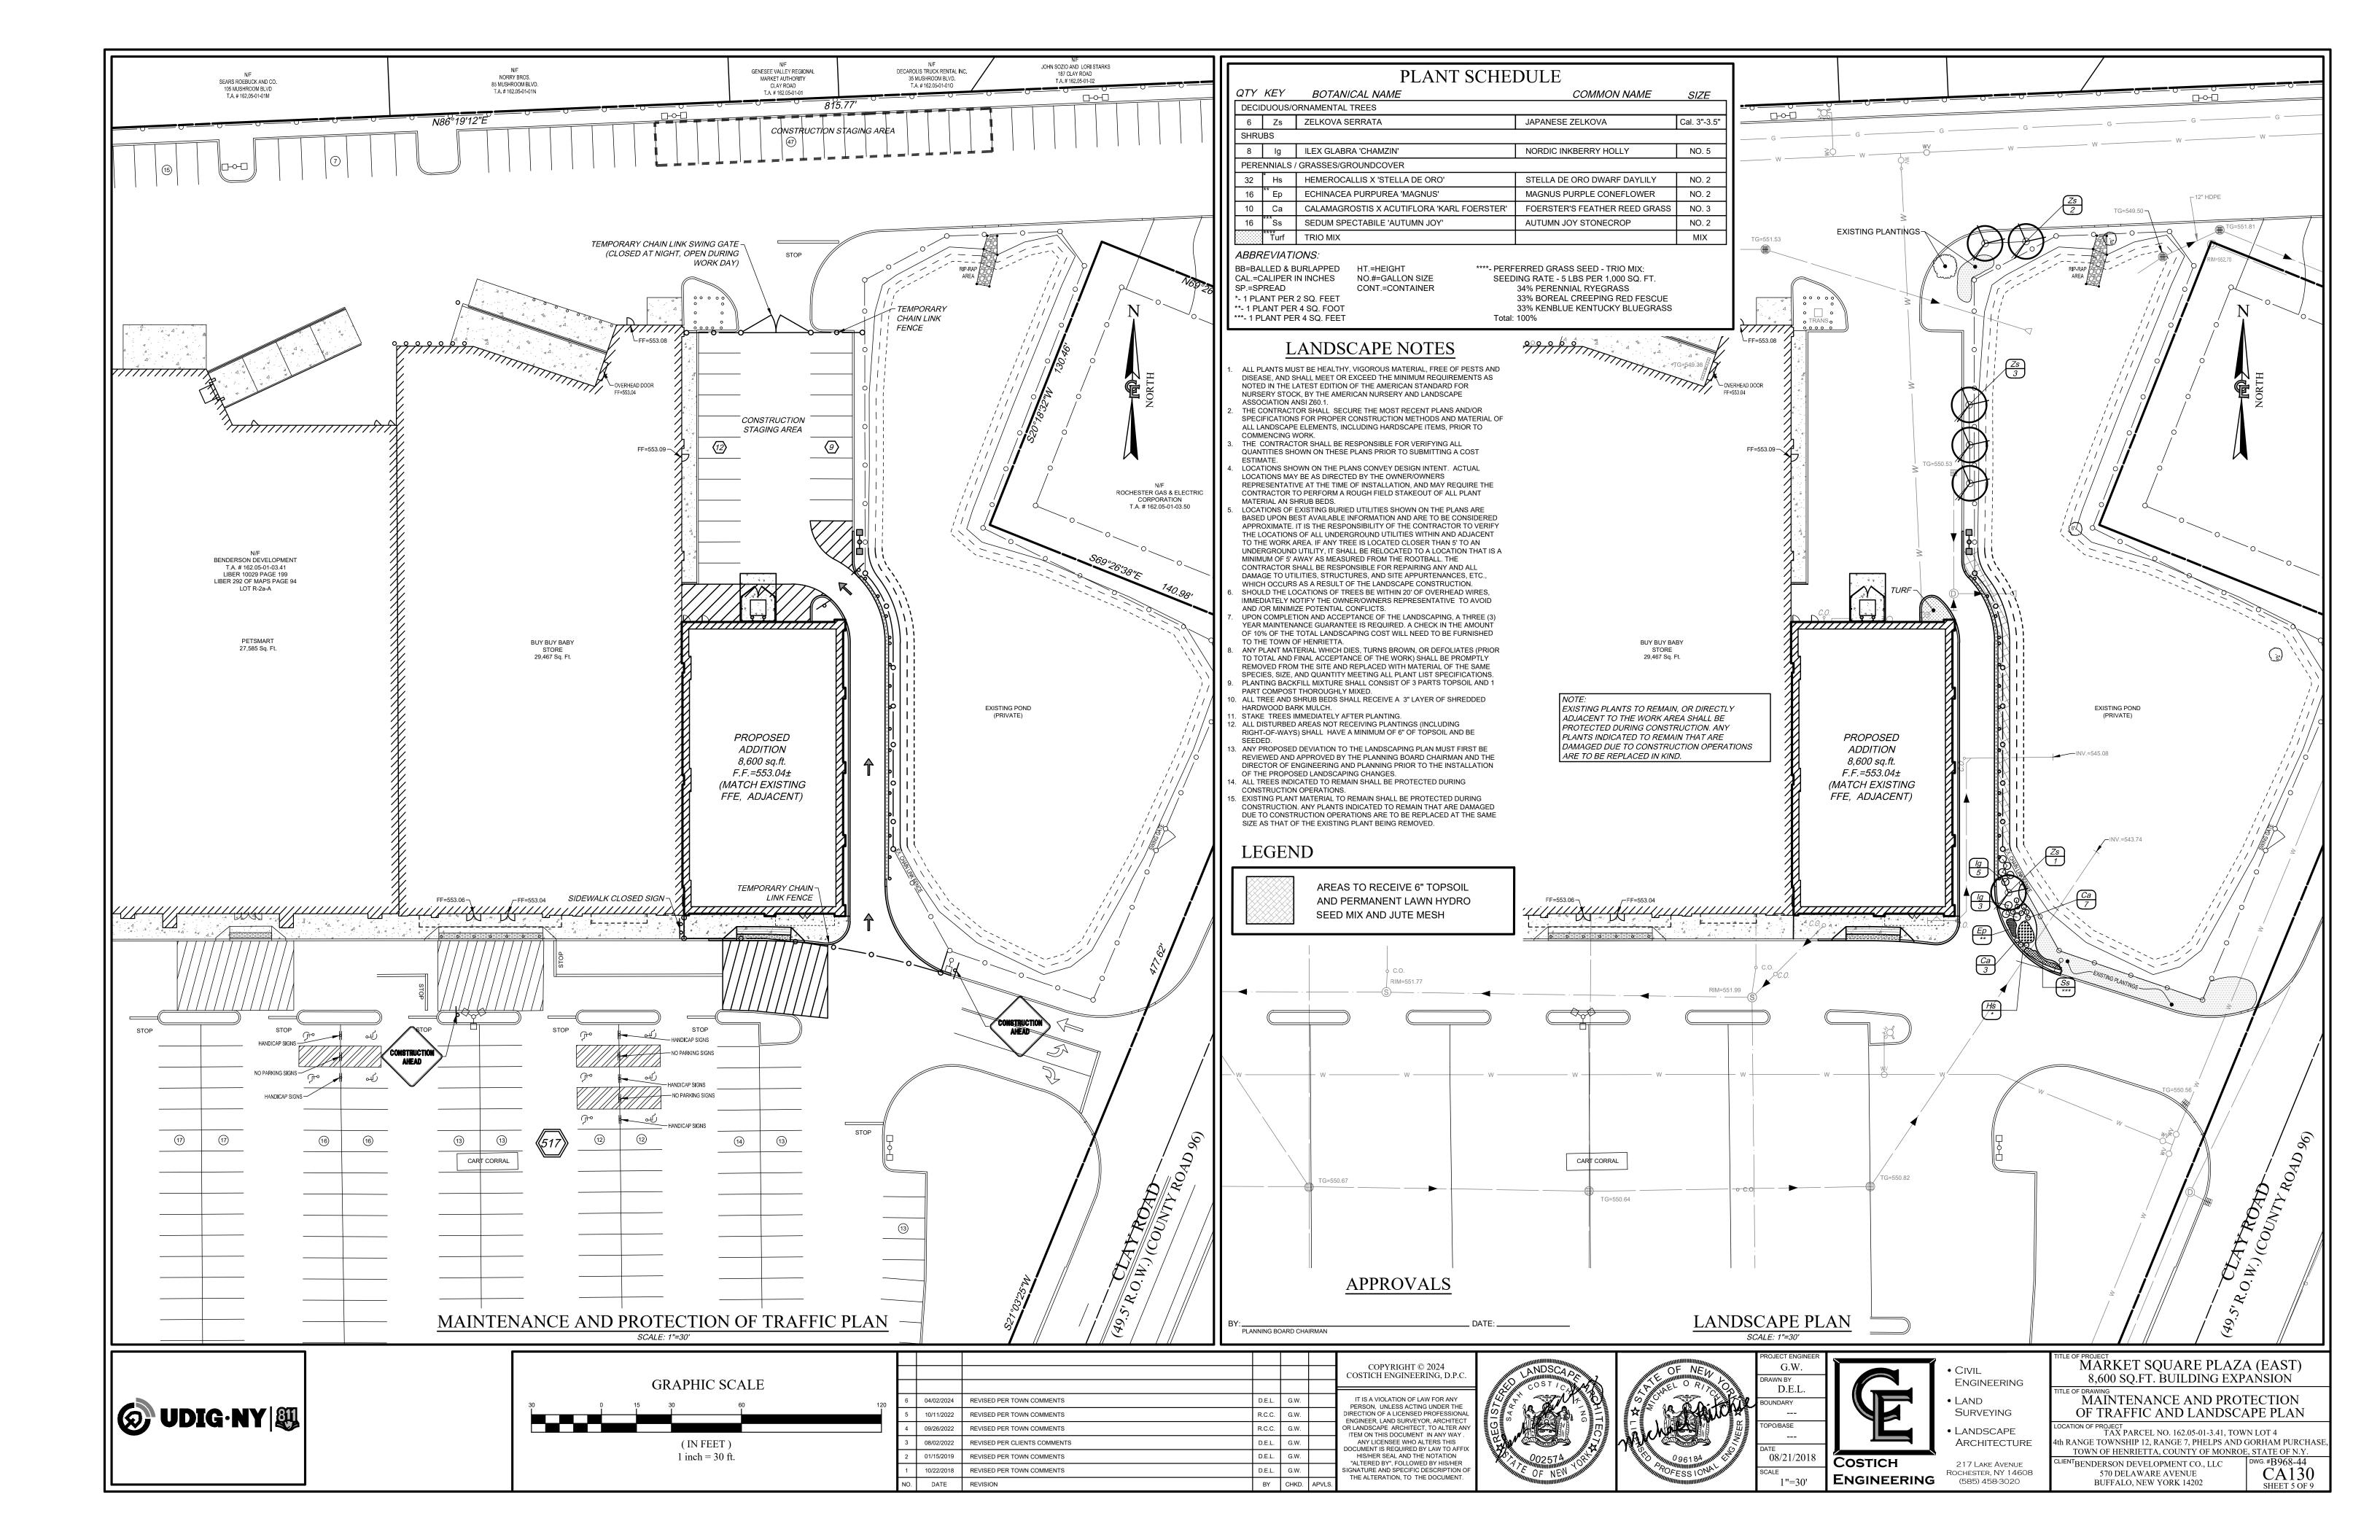
> **TOWN OF HENRIETTA COUNTY OF MONROE** STATE OF NEW YORK

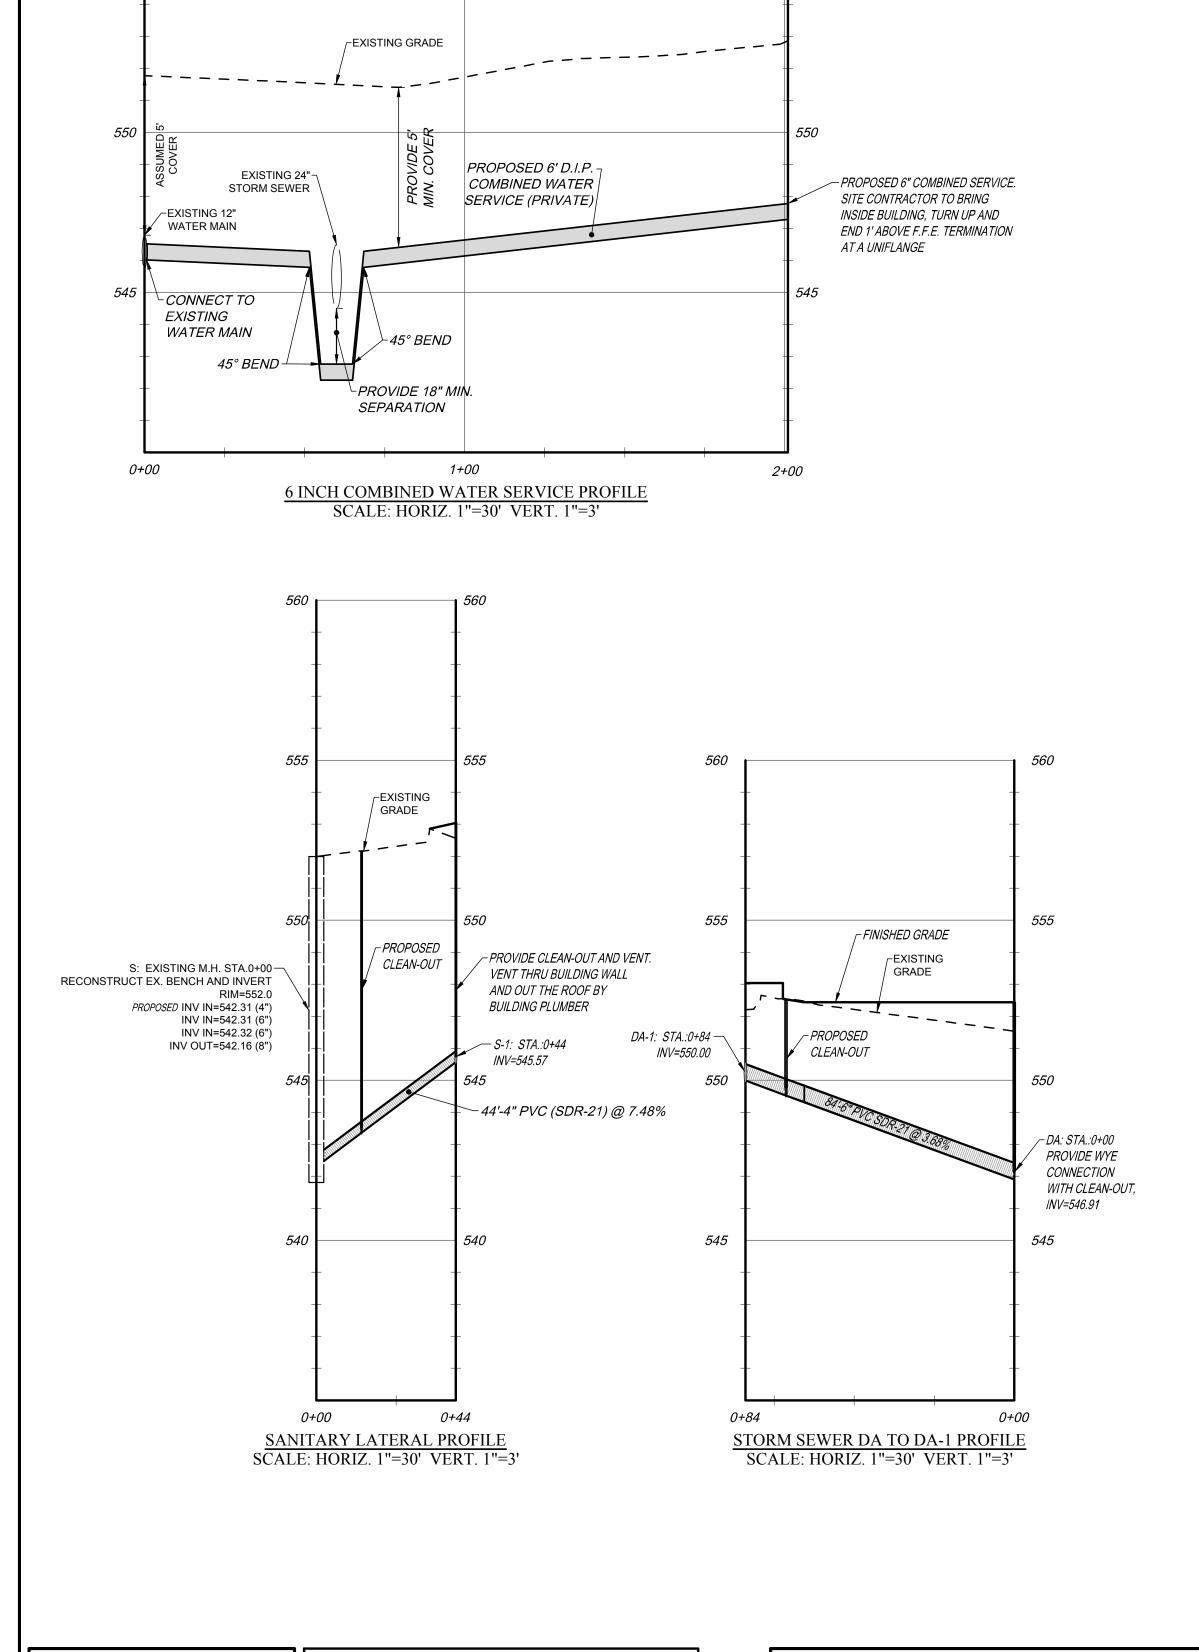
TOWN APPLICATION NO. 18-011 AND 24-001 APPROVAL PLANS PROJECT NO. **B968-44** SHEET NO. **GA001**














PLANS ARE APPROXIMATE AND ARE NOT CERTIFIED AS TO THE ACCURACY OF THEIR LOCATION OR COMPLETENESS. THE CONTRACTOR SHALL BE RESPONSIBLE FOR DETERMINING THE EXACT LOCATIONS AND DEPTHS OF ALL UTILITIES AND STRUCTURES IN THE PATH OF, OR CLOSELY PARALLEL TO, OR UNDER, THE PROPOSED CONSTRUCTION. THE CONTRACTOR SHALL BE RESPONSIBLE FOR ANY DELAYS OR DAMAGES OCCURRING AS A RESULT OF INCORRECTLY LOCATED UTILITIES. IT IS THE CONTRACTORS RESPONSIBILITY TO NOTIFY THE VARIOUS UTILITY OWNERS IN AMPLE TIME FOR THEM TO LOCATE AND MARK THEIR FACILITIES. THE CONTRACTOR SHALL ALSO NOTIFY UNDERGROUND UTILITY LOCATION SERVICE AT LEAST 48 HOURS IN ADVANCE OF COMMENCING ANY WORK.

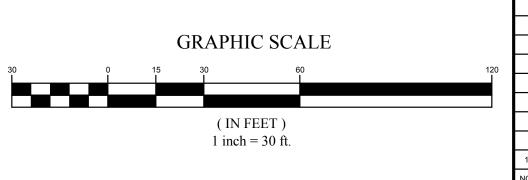EXISTING UTILITIES (LOCATION, SIZES AND INVERTS) SHOWN ON THE



					COPYRIGHT © 2024 COSTICH ENGINEERING, D.P.C.
10/22/2018 DATE	REVISED PER TOWN COMMENTS REVISION	D.E.L.	G.W.	APVLS.	IT IS A VIOLATION OF LAW FOR ANY PERSON, UNLESS ACTING UNDER THE DIRECTION OF A LICENSED PROFESSIONAL ENGINEER, LAND SURVEYOR, ARCHITECT OR LANDSCAPE ARCHITECT, TO A LITE ANY ITEM ON THIS DOCUMENT IN ANY WAY. ANY LICENSEE WHO ALTERS THIS DOCUMENT IS REQUIRED BY LAW TO AFFIX HIS/HER SEAL AND THE NOTATION "ALTERED BY", FOLLOWED BY HIS/HER SIGNATURE AND SPECIFIC DESCRIPTION OF THE ALTERATION, TO THE DOCUMENT.

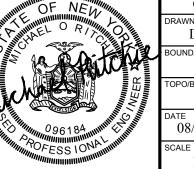

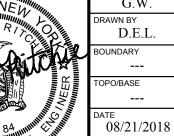

Costich

CIVIL Land

COSTICH 217 LAKE AVENUE ROCHESTER, NY 14608 (585) 458-3020

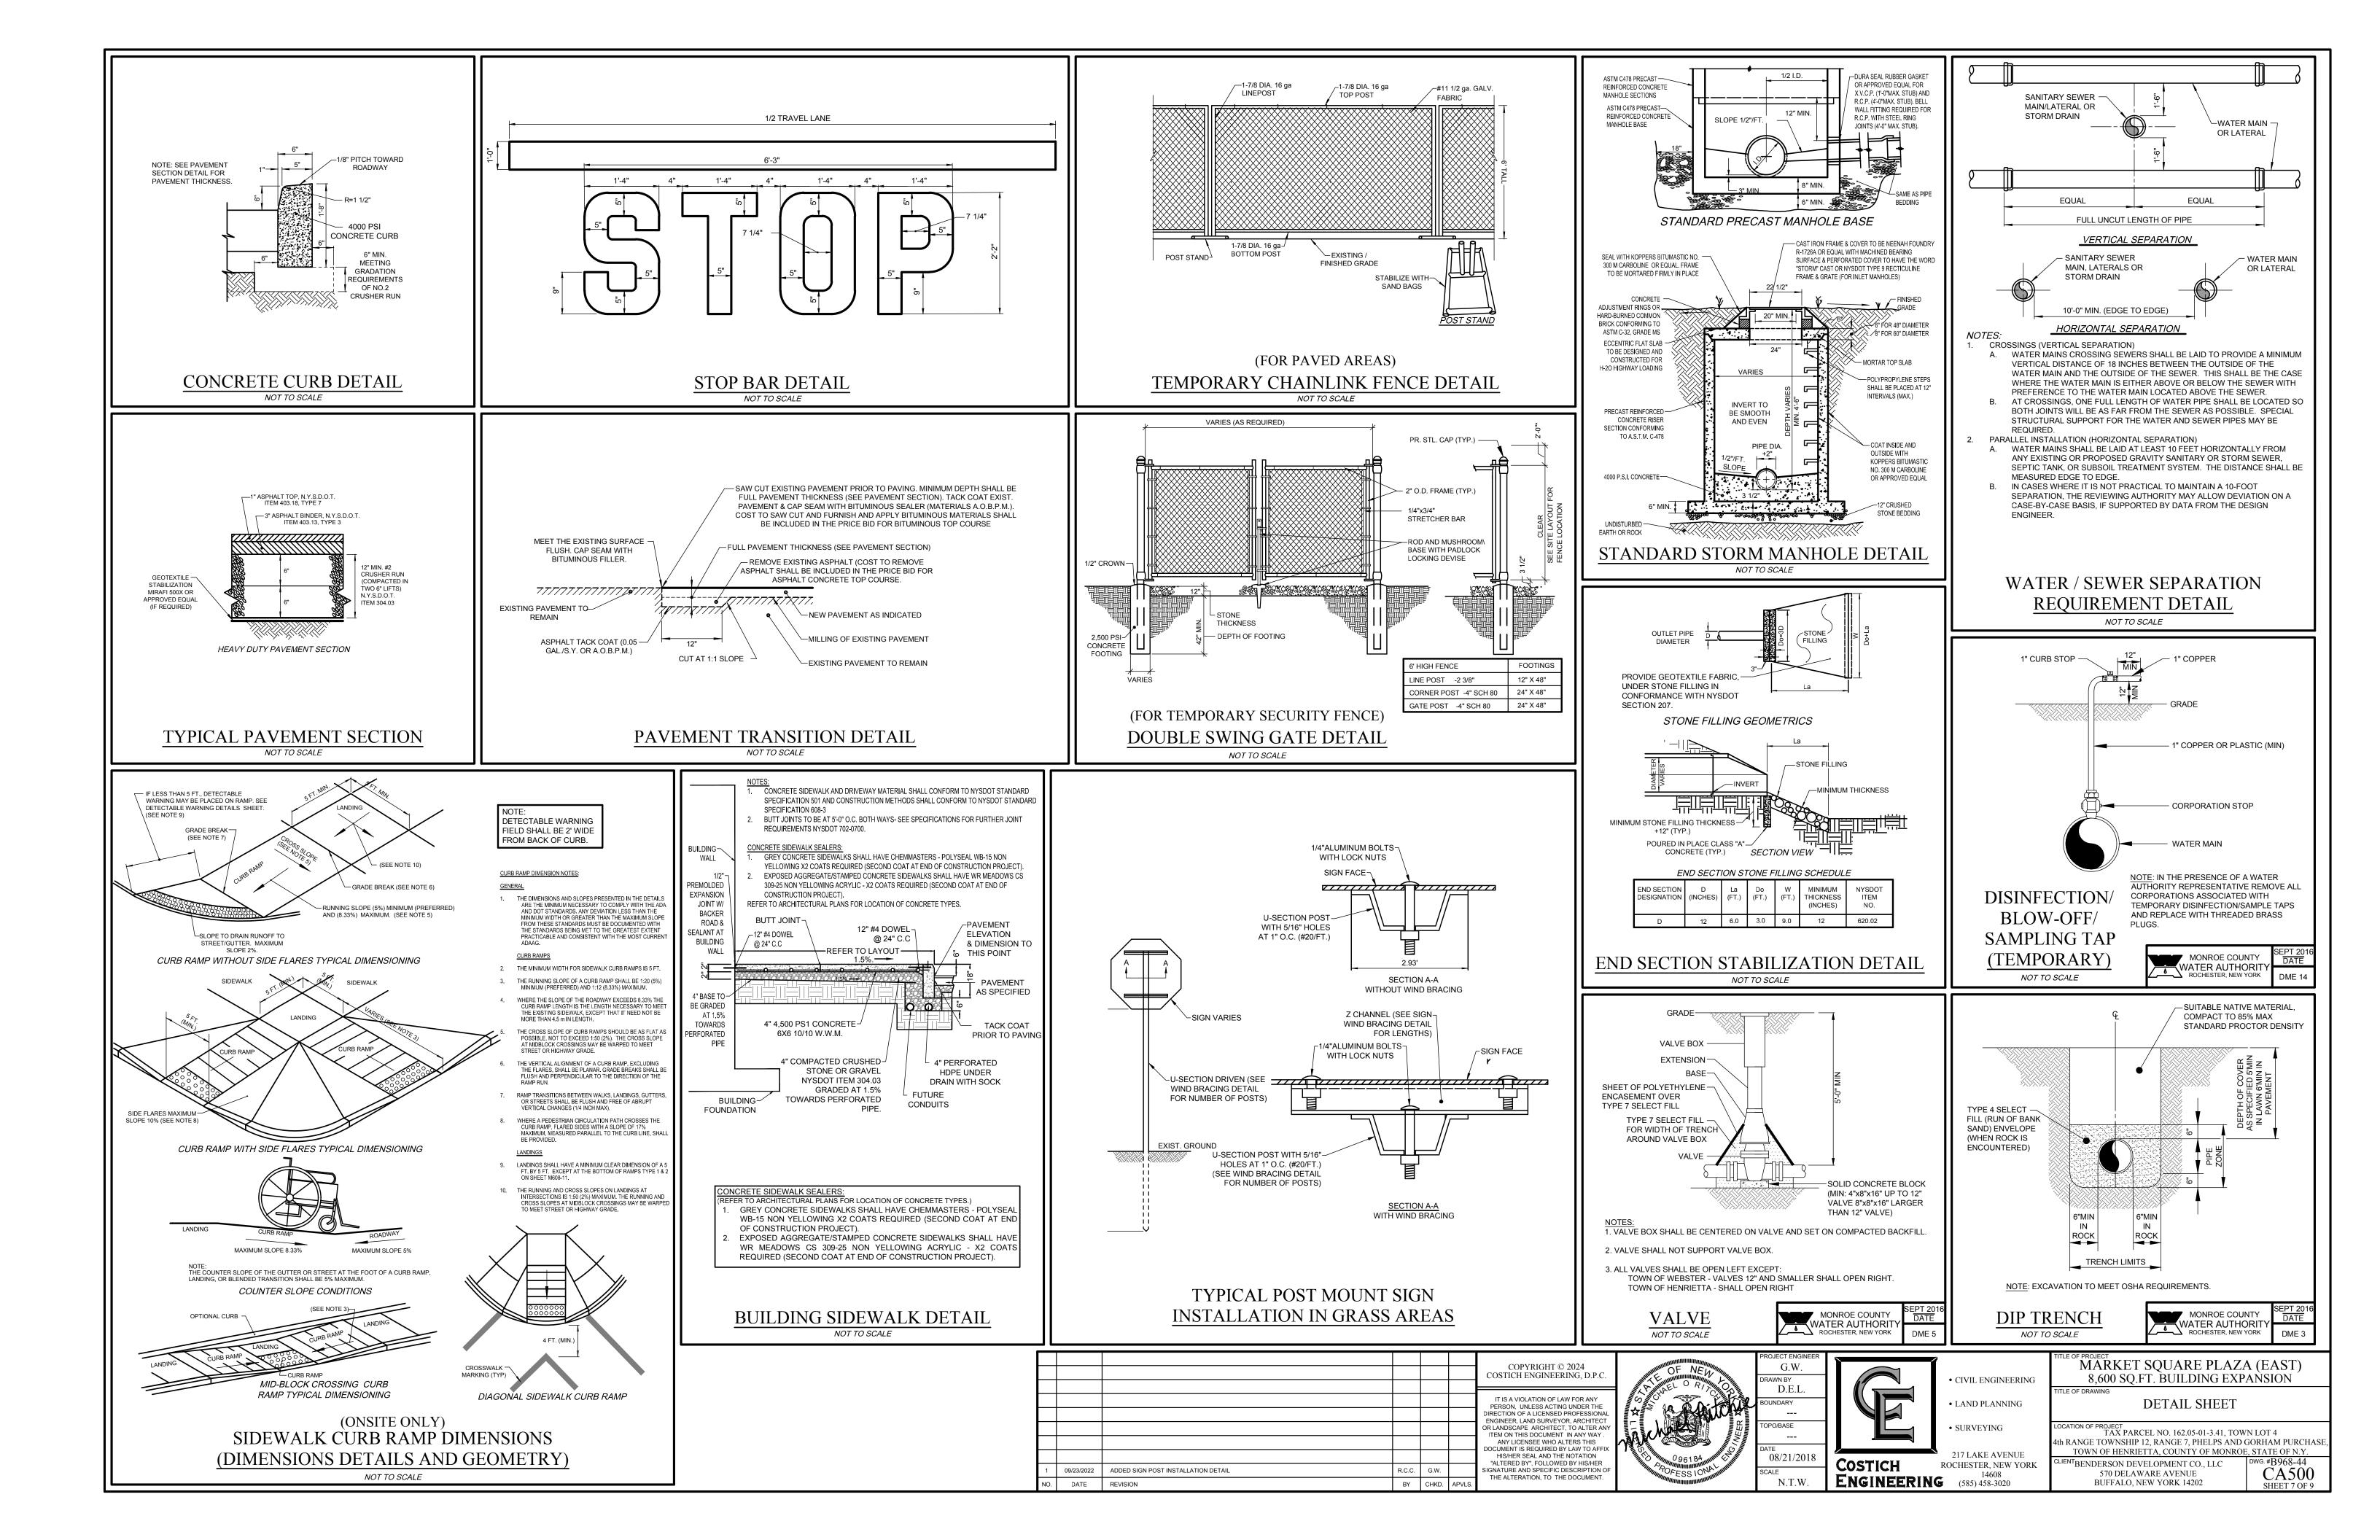
ENGINEERING

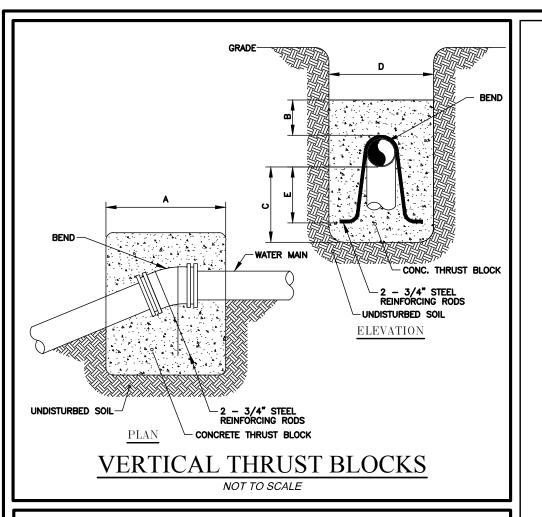
SURVEYING

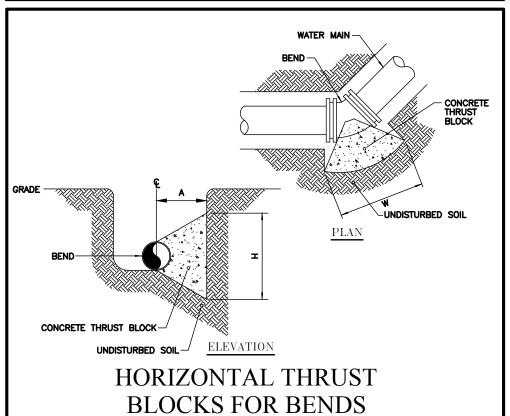
UTILITY PROFILE SHEET TAX PARCEL NO. 162.05-01-3.41, TOWN LOT 4 LANDSCAPE ARCHITECTURE

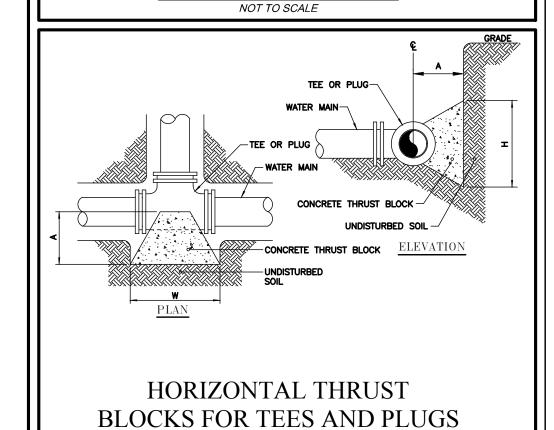
4th RANGE TOWNSHIP 12, RANGE 7, PHELPS AND GORHAM PURCHASE TOWN OF HENRIETTA, COUNTY OF MONROE, STATE OF N.Y. NTBENDERSON DEVELOPMENT CO., LLC CA300 SHEET 6 OF 9 570 DELAWARE AVENUE BUFFALO, NEW YORK 14202

MARKET SQUARE PLAZA (EAST) 8,600 SQ.FT. BUILDING EXPANSION











NOT TO SCALE

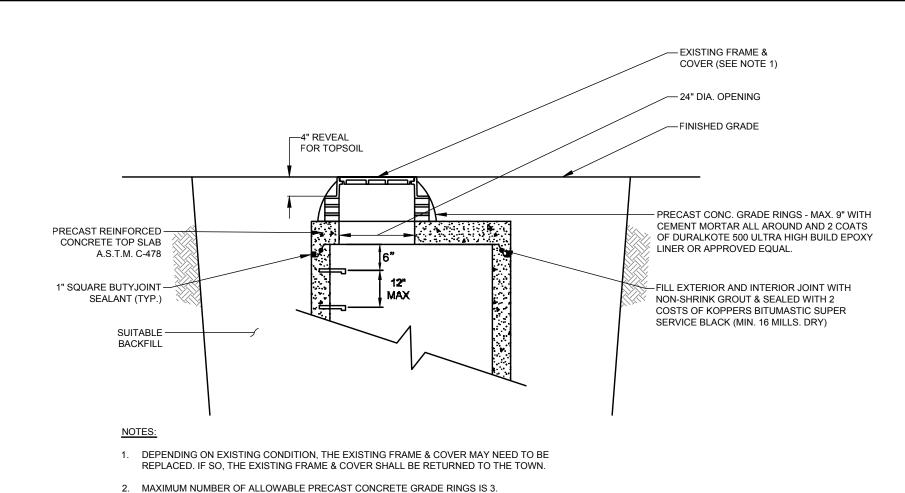


3. DEPENDING ON THE DEPTH OR AN ECCENTRIC CONE SECTION ENCOUNTERED, THE


CONTRACTOR MAY BE REQUIRED TO ADJUST THE MANHOLE UTILIZING PRECAST

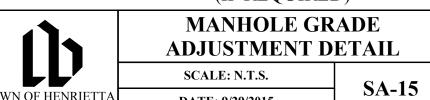(IF REQUIRED)



DATE: 9/29/2015

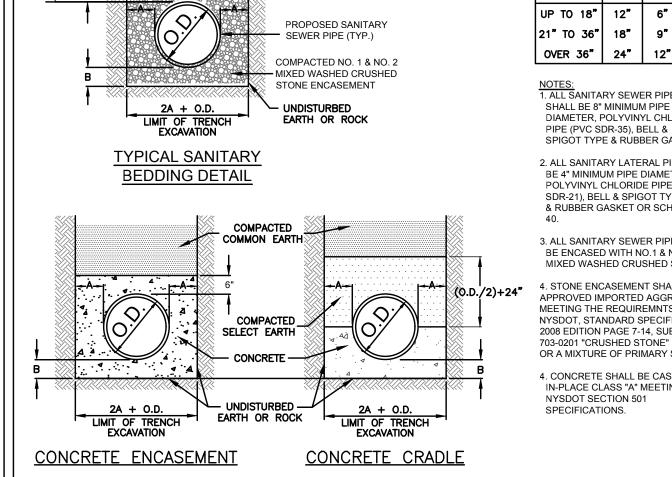

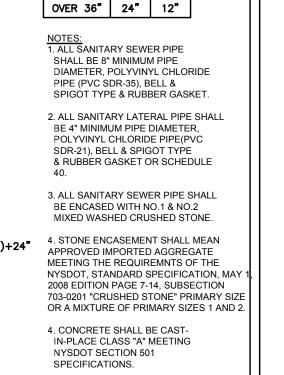

SA-01

FINISHED GRAD

- 6" TOPSOIL

NO. 4 REINFORCEMENT

PLACED ON THE STREET

BAR 12" IN LENGTH

SIDE OF CLEANOUT


TYPICAL SANITARY PIPE

BEDDING DETAILS

SCALE: N.T.S.

DATE: 11/15/2011

PIPE DIA. | A | B

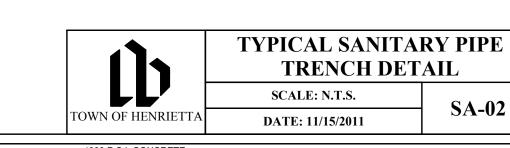

DEPTH OF COVER

5'-0" MINIMUM

RESTORATION

WITHIN PAVED AREAS OUTSIDE PAVED AREAS

TRENCH EXCAVATION

-6" TOPSOIL AND HYDROSEED

COMPACTED SELECT EARTH

THAN 4" IN SIZE TO BE

- NEW SANITARY SEWER

- COMPACTED NO.1 & NO. 2 MIXED

CRUSHED WASHED STONE EMBEDMENT

COMPACTED IN 12" LIFTS

WITH NO AGGREGATE LARGER

WITHIN LAWN AREAS

REPLACE PAVEMENT IN KIND

(SEE TYPICAL PAVEMENT

SECTION DETAIL)

STRAIGHT SAW CUT, -

TACK COATED, AND

SEALED WITH HOT

SELECT GRANLILAR FILL -

N.Y.S.D.O.T. ITEM 203.07

COMPACTED IN 6" LIFTS

WITH 4" MAX. SIZE

AGGREGATE TO BE

UNDISTURBED EARTH -

SANITARY PIPE

BEDDING PETAILS

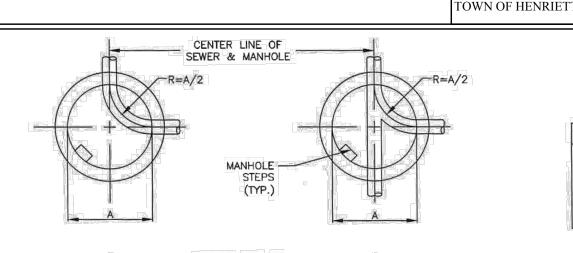
JOINT SEALANT

AS PER PLAN WHERE REQUIRED


CONTRACTOR TO PROVIDE SAFE-


EXCAVATION BY SLOPING, SHEETING &

BRACING PER OSHA SPECIFICATIONS



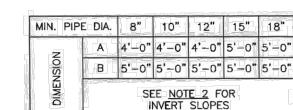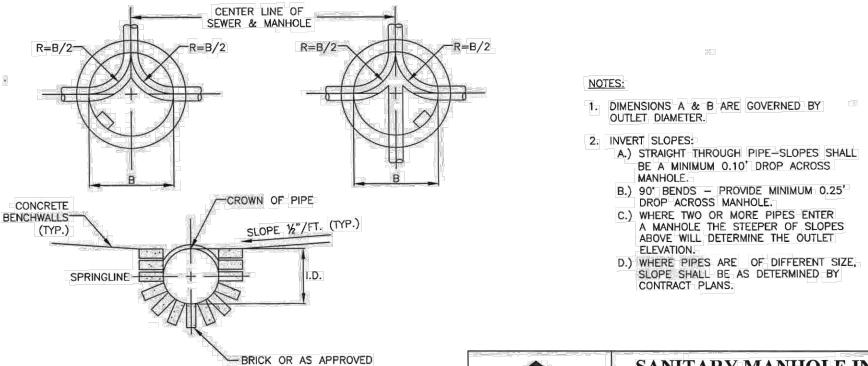
REINFORCED CONCRETE BARREL RISER SECTIONS.






TOWN OF HENRIETTA

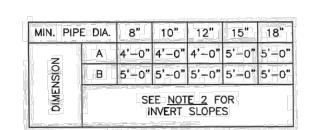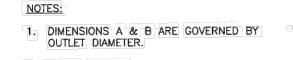BY THE TOWN ENGINEER.






- BE A MINIMUM 0.10 DROP ACROSS B.) 90' BENDS - PROVIDE MINIMUM 0.25'
- A MANHOLE THE STEEPER OF SLOPES ABOVE WILL DETERMINE THE OUTLET
- SANITARY MANHOLE INVERT CONFIGURATIONS & DIMENSIONS

SA-09

SCALE: N.T.S.

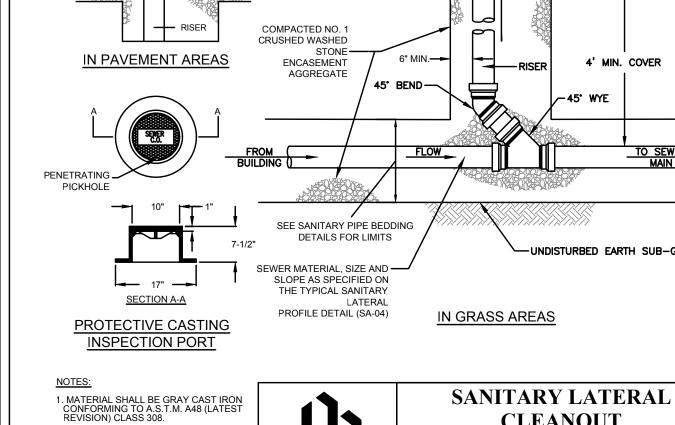DATE: 5/1/2019





OWN OF HENRIETT


THREADED STEEL CAP -


THREADED COUPLING

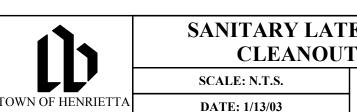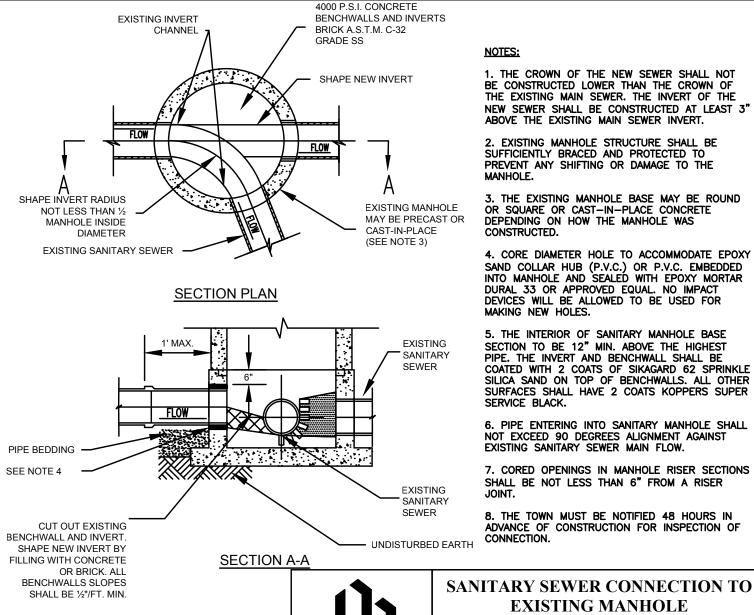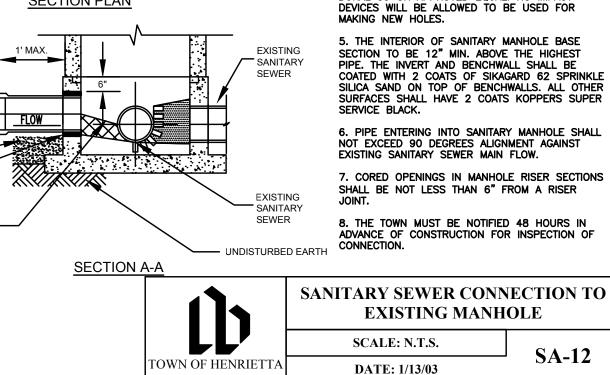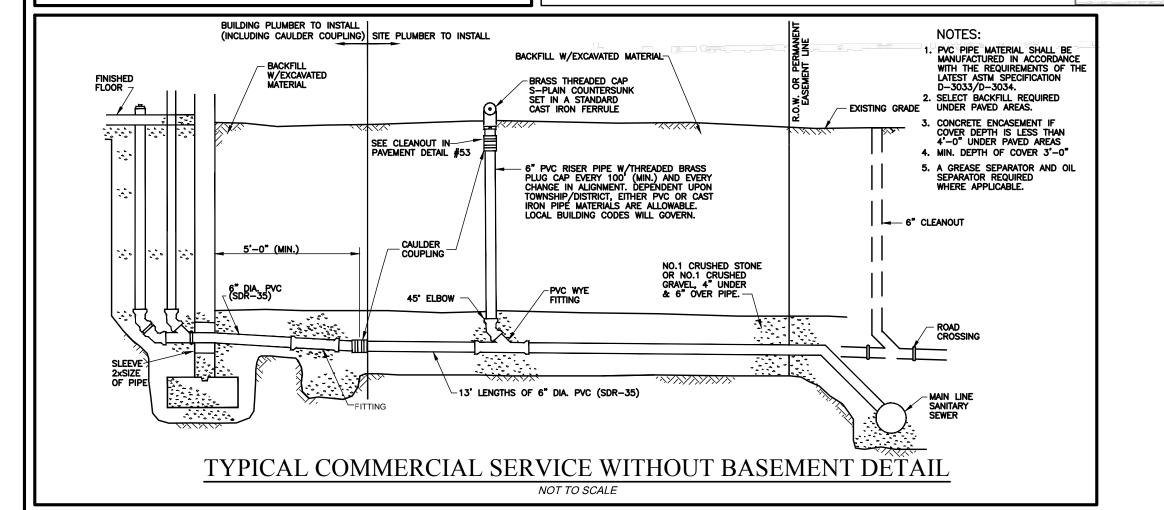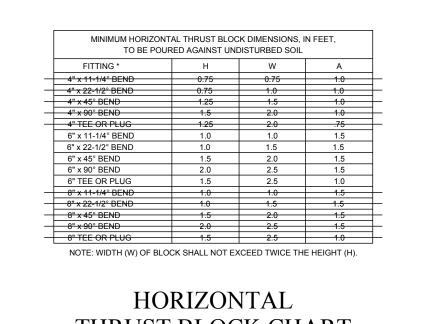
NSPECTION PORT











2. HEAVY DUTY CASTING SHALL BE DESIGNED FOR A.A.S.H.T.O. H20-16 WHEEL LOADS.

MODEL NO. 4155 OR WITH THE LETTERING "SEWER C.O." CASTED IN

PAVEMENT

COVER

THRUST BLOCK CHART NOT TO SCALE

BE	ND *	MINIMUM VOLUME OF CONCRETE		MINIMUM ALLOWABLE DIMENSIONS FOR VERTICAL THRUST BLOCKS (IN FEET)			
		DIMENSIONS	Α	В	С	D	E
4" x	11-1/4°	6 CF	2.0	0.5	1.5	2.0	1.0
4" x	22-1/2°	11 CF	2.5	1.0	1.5	2.5	1.0
4" x	45°	20 CF	3.0	1.0	2.0	2.5	1.5
6" x	11-1/4°	1.00 CY	3.0	1.0	1.3	3.0	1.0
6" x	22-1/2°	1.50 CY	4.0	1.0	1.8	3.0	1.5
6" x	45°	2.50 CY	6.0	1.5	2.0	3.0	1.7
8" x	11-1/4°	1.00 CY	3.0	1.0	1.3	3.0	1.0
8" x	22-1/2°	1.50 CY	4.0	1.0	1.8	3.0	1.5
8" x	45°	2.50 CY	6.0	1.5	2.0	3.0	1.7
12">	: 11-1/4°	1.50 CY	5.0	1.0	1.5	3.0	1.3
12">	22-1/2°	3.00 CY	6.0	1.5	2.5	3.0	2.0
12">	: 45°	5.50 CY	8.0	2.5	3.0	3.0	2.5
16">	: 11-1/4°	2.50 CY	5.0	1.0	2.1	3.0	1.8
16">	22-1/2°	5.25 CY	7.5	2.0	2.6	3.5	2.3
16">	45°	9.50 CY	9.0	2.5	3.4	4.0	3.0

SA-07

VERTICAL THRUST BLOCK CHAR	<u>T</u>
NOT TO SCALE	

FINISHED GRADE					
PAVEMENT AS REQ'D —	6" TOPSOIL				
PAV'T SUBBASE AS REQUIRED	NATIVE SOIL WITH 3" MAX. SIZE AGGREGATE COMPACTED IN 6" LIFTS. IN NON-PAVEMENT AREAS				
NO. 2 CRUSHER RUN STONE COMPACTED IN 6" LIFTS.	PIPE INSIDE DIA. A B UP TO 24" 12" 6" OVER 24" 18" 12"				
UNDISTURBED - GROUND OR ROCK	A COMPACTED SELECT FILL TO ROAD SUBBASE IN PAVEMENT AREAS. SELECT FILL SHALL BE TYPE 2, CRUSHER RUN STONE MATERIAL WHICH SHALL BE FREE FROM CLAY, LOAM, ORGANIC MATERIAL, DEBRIS, OR FROZEN MATERIAL, AND SHALL CONTAIN NO STONES PEBBLES OR LUMPS OVER 2" IN GREATEST DIMENSION.				
	NO.2 CRUSHED STONE				
STORM SEWER & STORM SEWER					
LATERAL BEDDING DETAIL					

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						IT IS A VIOLATION OF LAW FOR ANY PERSON, UNLESS ACTING UNDER THE
_						DIRECTION OF A LICENSED PROFESSIONAL ENGINEER, LAND SURVEYOR, ARCHITECT OR LANDSCAPE ARCHITECT, TO ALTER ANY
	01/24/2023	ADDED TYPICAL COMMERCIAL SERVICE WITHOUT BASEMENT DETAIL	D.E.L.	G.W.		ITEM ON THIS DOCUMENT IN ANY WAY . ANY LICENSEE WHO ALTERS THIS DOCUMENT IS REQUIRED BY LAW TO AFFIX
	10/10/2022	REPLACED DETAIL SA-09 WITH CURRENT TOWN DETAIL	R.C.C.	G.W.		HIS/HER SEAL AND THE NOTATION "ALTERED BY", FOLLOWED BY HIS/HER
	09/23/2022	UPDATED TOWN INLET MANHOLE DETAIL	R.C.C.	G.W.		SIGNATURE AND SPECIFIC DESCRIPTION OF THE ALTERATION. TO THE DOCUMENT.
١.	DATE	REVISION	BY	CHKD.	APVLS.	THE ALTERATION, TO THE DOCUMENT.

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	• CIVIL ENGINEERING
	• LAND PLANNING
	• SURVEYING

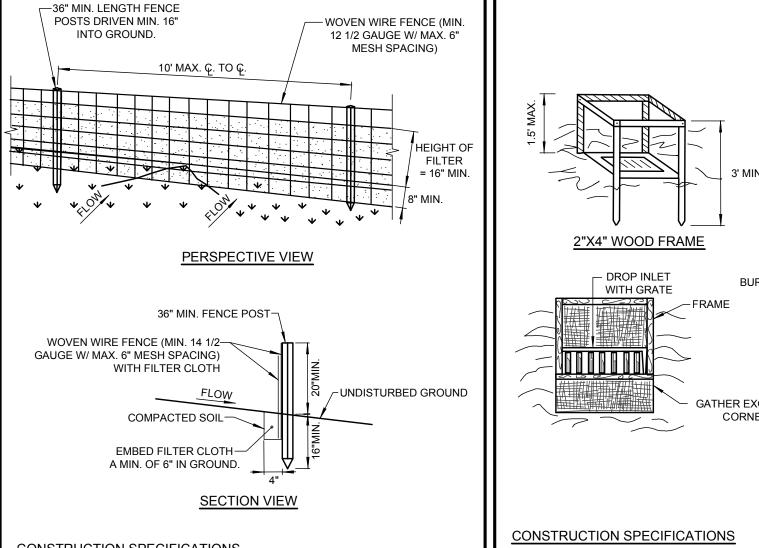
217 LAKE AVENUE ROCHESTER, NEW YORK

ENGINEERING (585) 458-3020

MARKET SQUARE PLAZA (EAST) 8,600 SQ.FT. BUILDING EXPANSION DETAIL SHEET

NOT TO SCALE


OCATION OF PROJECT
TAX PARCEL NO. 162.05-01-3.41, TOWN LOT 4 th RANGE TOWNSHIP 12, RANGE 7, PHELPS AND GORHAM PURCHAS TOWN OF HENRIETTA, COUNTY OF MONROE, STATE OF N.Y. NTBENDERSON DEVELOPMENT CO., LLC CA501 SHEET 8 OF 9 570 DELAWARE AVENUE BUFFALO, NEW YORK 14202



CONSTRUCTION SPECIFICATIONS

- WOVEN WIRE FENCE TO BE FASTENED SECURELY TO FENCE POSTS WITH WIRE TIES OR STAPLES. POSTS SHALL BE STEEL EITHER "T" OR "U" TYPE OR HARDWOOD.
- FILTER CLOTH TO BE FASTENED SECURELY TO WOVEN WIRE FENCE WITH TIES SPACED EVERY 24" AT TOP AND MID SECTION. FENCE SHALL BE WOVEN WIRE, 12 1/2 GAUGE, 6" MAXIMUM MESH OPENING.
- WHEN TWO SECTIONS OF FILTER CLOTH ADJOIN EACH OTHER THEY SHALL BE OVERLAPPED BY SIX INCHES AND FOLDED. FILTER CLOTH SHALL BE EITHER FILTER X, MIRAFI 100X, STABILINKA T140N, OR APPROVED EQUIVALENT.
- PREFABRICATED UNITS SHALL BE GEOFAB, ENVIROFENCE, OR APPROVED EQUIVALENT.
- MAINTENANCE SHALL BE PERFORMED AS NEEDED AND MATERIAL REMOVED WHEN "BULGES" DEVELOP IN THE SILT FENCE OR 50% OF THE HEIGHT OF THE SILT FENCE IS COVERED.

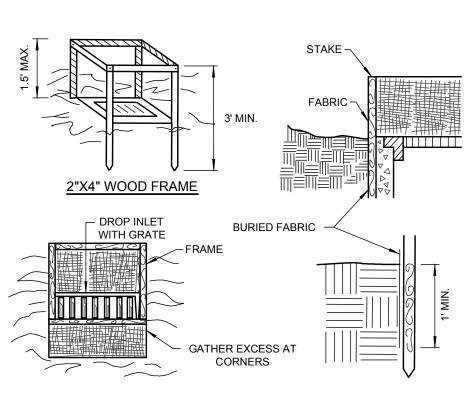SILT FENCE DETAIL NOT TO SCALE




- FILTER FABRIC SHALL HAVE AN EOS OF 40-85. BURLAP MAY BE USED FOR SHORT TERM APPLICATIONS.
- CUT FABRIC FROM A CONTINUOUS ROLL TO ELIMINATE JOINTS. IF JOINTS ARE NEEDED THEY WILL BE OVERLAPPED TO THE NEXT STAKE. STAKE MATERIALS WILL BE STANDARD 2" x 4" WOOD OR EQUIVALENT. METAL WITH
- A MINIMUM LENGTH OF 3 FEET. SPACE STAKES EVENLY AROUND INLET 3 FEET APART AND DRIVE A MINIMUM 18 INCHES DEEP. SPANS GREATER THAN 3 FEET MAY BE BRIDGED WITH THE USE OF
- WIRE MESH BEHIND THE FILTER FABRIC FOR SUPPORT. FABRIC SHALL BE EMBEDDED 1 FOOT MINIMUM BELOW GROUND AND BACKFILLED IT SHALL BE SECURELY FASTENED TO THE STAKES AND FRAME.
- A 2" x 4" WOOD FRAME SHALL BE COMPLETED AROUND THE CREST OF THE FABRIC FOR OVER FLOW STABILITY. MAINTENANCE SHALL BE PERFORMED AS NEEDED AND MATERIAL REMOVED
- WHEN "BULGES" DEVELOP IN THE SILT FENCE OR 50% OF THE HEIGHT OF THE SILT FENCE IS COVERED


MAXIMUM DRAINAGE AREA 1 ACRE

FILTER FABRIC DROP INLET PROTECTION DETAIL

NOT TO SCALE

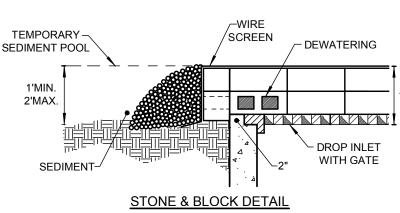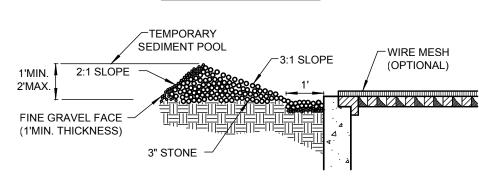STONE & BLOCK PLAN VIEW





CONSTRUCTION SPECIFICATIONS

LAY ONE BLOCK ON EACH SIDE OF THE STRUCTURE ON ITS SIDE FOR DEWATERING. FOUNDATION SHALL BE 2 INCHES MINIMUM BELOW REST OF INLET AND BLOCKS SHALL BE PLACED AGAINST INLET FOR SUPPORT.

"DOUGHNUT" DETAIL

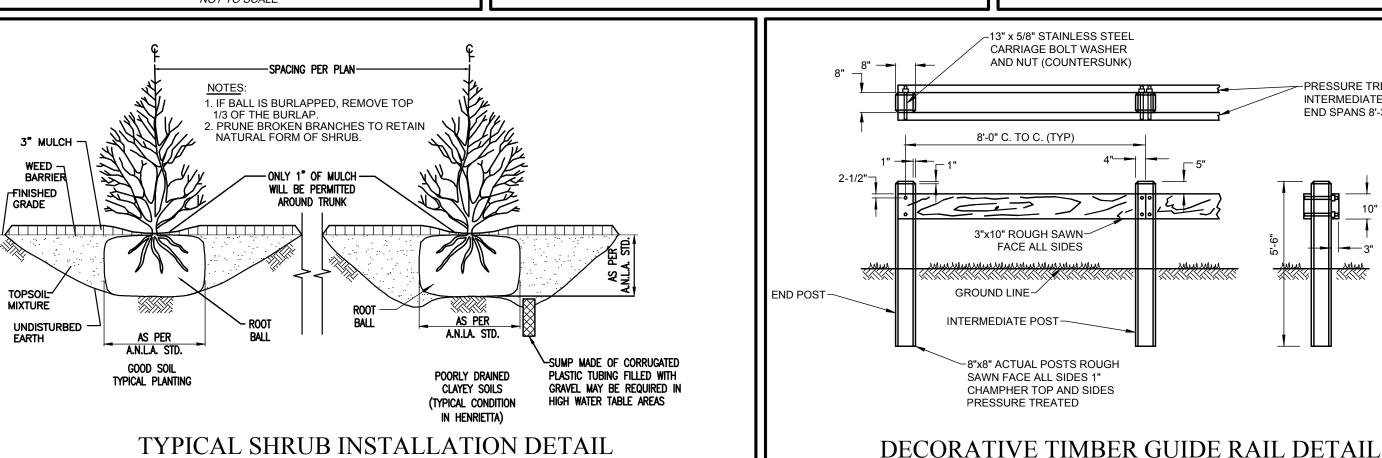
- HARDWARE CLOTH OR 1/2" WIRE MESH SHALL BE PLACED OVER BLOCK OPENINGS TO SUPPORT STONE
- USE CLEAN STONE OR GRAVEL 1/2-3/4 INCH IN DIAMETER PLACED 2 INCHES BELOW TOP OF THE BLOCK ON A 2:1 SLOPE OR FLATTER.
- FOR STONE STRUCTURES ONLY, A 1 FOOT THICK LAYER OF THE FILTER STONE WILL BE PLACED AGAINST THE 3 INCH STONE AS SHOWN ON THE DRAWINGS. MAXIMUM DRAINAGE AREA 1 ACRE

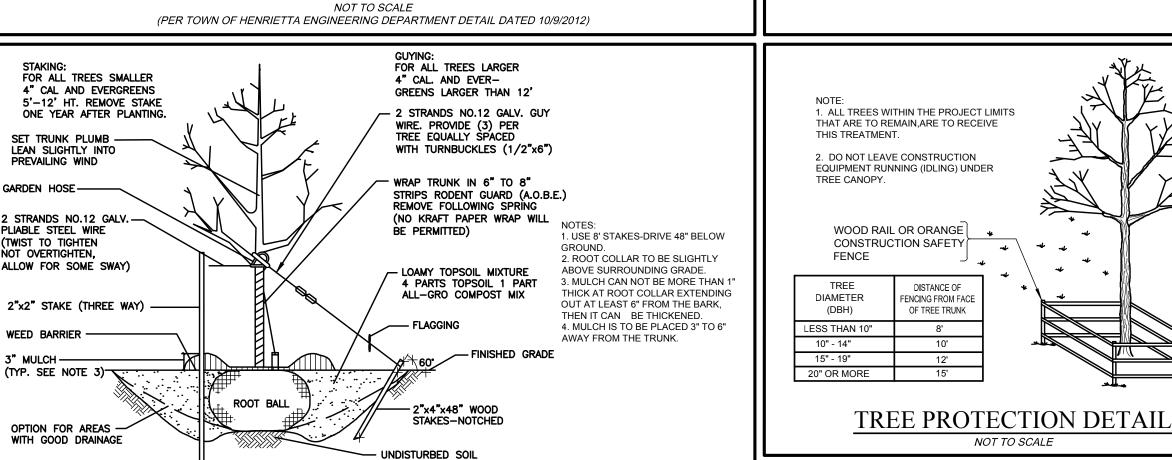
STONE AND BLOCK DROP INLET PROTECTION DETAIL

NOT TO SCALE

-PRESSURE TREATED LENGTHS: INTERMEDIATE SPANS - 8'-0"

END SPANS 8'-3"





TYPICAL TREE PLANTING DETAIL

NOT TO SCALE (PER TOWN OF HENRIETTA ENGINEERING DEPARTMENT DETAIL DATED 11/10/2011

STANDARD AND SPECIFICATIONS FOR CONCRETE TRUCK WASHOUT



Definition & Scope

A temporary excavated or above ground lined constructed pit where concrete truck mixers and equipment can be washed after their loads have been discharged, to prevent highly alkaline runoff from entering storm drainage systems or leaching into soil.

Conditions Where Practice Applies

Washout facilities shall be provided for every project where concrete will be poured or otherwise formed on the site. This facility will receive highly alkaline wash water from the cleaning of chutes, mixers, hoppers, vibrators, placing equipment, trowels, and screeds. Under no circumstances will wash water from these operations be allowed to infiltrate into the soil or enter surface waters.

Design Criteria

November 2016

Capacity: The washout facility should be sized to contain solids, wash water, and rainfall and sized to allow for the evaporation of the wash water and rainfall. Wash water shall be estimated at 7 gallons per chute and 50 gallons per hopper of the concrete pump truck and/or discharging drum. The minimum size shall be 8 feet by 8 feet at the bottom and 2 feet deep. If excavated, the side slopes shall be 2 horizontal to 1 vertical.

Location: Locate the facility a minimum of 100 feet from drainage swales, storm drain inlets, wetlands, streams and other surface waters. Prevent surface water from entering the structure except for the access road. Provide appropriate access with a gravel access road sloped down to the structure. Signs shall be placed to direct drivers to the facility after their load is discharged.

Page 2.24

Liner: All washout facilities will be lined to prevent

leaching of liquids into the ground. The liner shall be plasti sheeting with a minimum thickness of 10 mils with no holes or tears, and anchored beyond the top of the pit with an

earthen berm, sand bags, stone, or other structural appurtenance except at the access point. If pre-fabricated washouts are used they must ensure the capture and containment of the concrete wash and be sized

based on the expected frequency of concrete pours. They

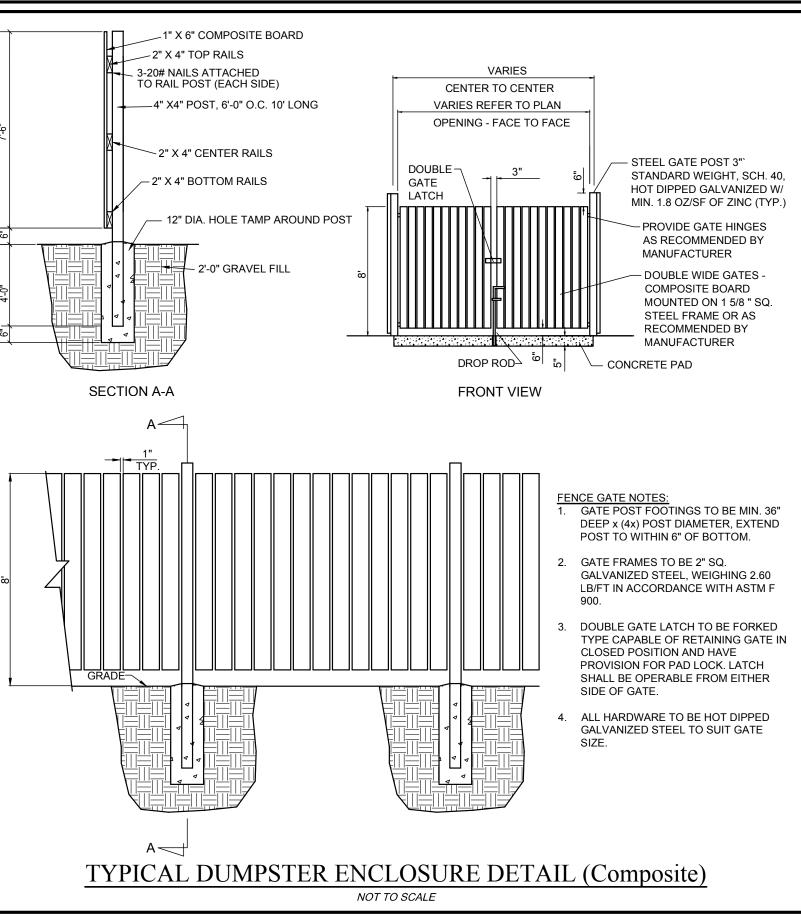
shall be sited as noted in the location criteria.

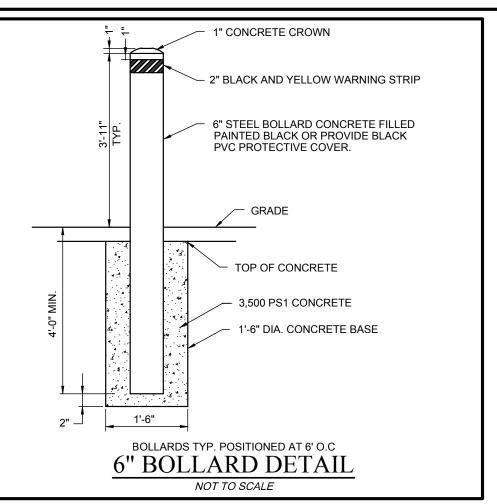
Maintenance

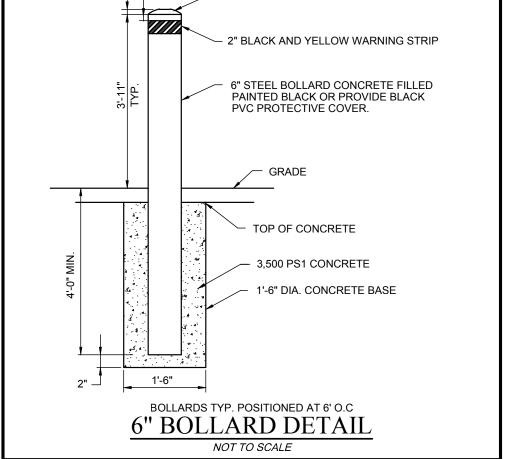
- All concrete washout facilities shall be inspected daily Damaged or leaking facilities shall be deactivated and repaired or replaced immediately. Excess rainwater that has accumulated over hardened concrete should be
- pumped to a stabilized area, such as a grass filter strip. Accumulated hardened material shall be removed when 75% of the storage capacity of the structure is filled. Any excess wash water shall be pumped into a containment vessel and properly disposed of off site.
- Dispose of the hardened material off-site in a construction/demolition landfill. On-site disposal may be allowed if this has been approved and accepted as part of the projects SWPPP. In that case, the material should be recycled as specified, or buried and covered with a minimum of 2 feet of clean compacted earthfill that is permanently stabilized to prevent erosion.
- The plastic liner shall be replaced with each cleaning of the washout facility.
- Inspect the project site frequently to ensure that no concrete discharges are taking place in non-designated

New York State Standards and Specifications

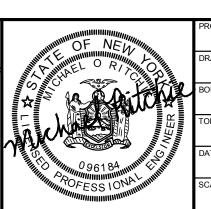
For Erosion and Sediment Control

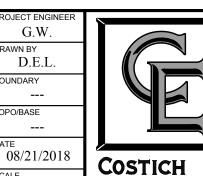






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